# ADDENDUM TO SPECIFICATIONS ENTITLED "Reroofing Construction Project At USC Old Observatory Building" DATED July 2020

ADDENDUM NO. 1 August 19, 2020

The Specifications and Drawings contained in the project manual "Reroofing Construction Project at USC Old Observatory Building" and dated July 2020 are amended as follows:

See attached sheet for record of conference call meeting attendants.

#### 1. PRE-BID DISCUSSION

- All attendees were advised that a roster of the participants in the pre-bid conference call will be kept and distributed by USC to all attendees.
- Mr. Dale Branham introduced himself, attending USC staff and Shepard & Associates and discussed project site location.
- Mr. Branham directed everyone's attention to the COVID-19 Construction Site Guidelines.
- Mr. Branham announced that the building would be un-occupied throughout the course
  of this project. He addressed specific restrictions for work taking place on the south main
  entrance to the building that faces the Horseshoe. This area will need to have temporary
  fencing with privacy fabric installed around the perimeter.
- Mr. Branham announced that the sidewalk on the north side of the building location will be the only access to the work. He also stated that the material storage and contractor parking area will need to have temporary fencing with privacy fabric installed around the perimeter. Contractor must obtain a minimum of 6 parking spaces on Pendleton street adjacent to the site. Pedestrian and vehicular traffic on the north side must be cleared with the City of Columbia.
- The University of South Carolina is a tobacco free campus. Absolutely no tobacco products are to be used while on campus.
- Ms. Hatice Hikmet discussed the specification front end documents and general requirements for the subject project.
- Ms. Hikmet announced that the bid opening date is Thursday, August 27, 2020 at 10:00am. Bids may be mailed to or dropped off at USC, 1600 Hampton Street, Suite 606, Columbia, SC 29208. Bids will be opened via Conference Call at 800-753-1965 Access Code 777-7162.
- All bids submitted are to be good for a period of no less than 60 days.
- Liquidated damages will be assessed against final payment in the amount of \$200.00 per day for every calendar day that final completion exceeds the established project end date.

Project No. FY21000007 PF 11012.022.004

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- Mr. Ty Russell reviewed the Hazmat survey which is included in the project specifications after SECTION 01010 SUMMARY OF ROOFING WORK as Exhibit A – Hazmat Exec Summary in the. There will be no Asbestos Containing Material (ACM) removal included in the Base Bid work.
  - The ceilings where access panels are to be installed contain ACBM and lead paint.
     Removals of this material will be performed by the USC staff prior to the work of this contract being performed.
- Mr. Dale Branham stated that the successful low contractor will be required to submit a safety plan for the project. The safety plan is to be included in the pre-work submittal package.
- Mr. Blount Shepard discussed the project existing conditions, removals, preparation requirements and installations of new materials during a review of the project specifications and drawings.
- The Bid Form was reviewed, and announcement made that all blanks on the form must be filled in by the Contractor.
- Bidders were informed that the Unit Price quantities expressed in the Bid Documents are to be included in the Base Bid price.
- The Owner wishes to have the project begin within 14 days after the Notice to Proceed and completed in a timely manner. The project must be substantially complete within 60 calendar days from the date of commencement.
- The Contractor will provide equipment for access to the roof. The Contractor will have limited access to the interior of the building during the course of the project to install ceiling view panels.
- There will be a requirement at the end of the project for the successful bidder to provide an Asbestos Free Warranty for all work at all location under this contract.
- There will be a requirement at the end of the project for the successful bidder to provide a 7-year workmanship warranty.

#### 2. SITE VISITS

- On Thursday August 13, 2020, Dale Branham, USC, and Adam Warren, S&A, met the following contractors on the building site: Randy Eddington (Waynco) – 9:00 AM; Kevin Nunnery (Nunnery Roofing) – 9:30 AM; and John Chan (Durable Slate) –11:30 AM.
- On Tuesday August 18, 2020, Dale Branham, USC, met with Robert Clark (Complete Solutions Contracting) in the morning.

#### 3. CLARIFICATIONS TO THE SPECIFICATION

 The project site is directly beside the Osborne Administration Building. If loud, continuous work on the project site is deemed too loud, the Contractor will be asked to stop all work. The Contract Duration will be extended day for day for any stoppage due this interruption. Work may have to be performed after hours or on the weekend at no additional cost to the University.

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#### 4. CHANGES TO SPECIFICATION

 In SECTION 075920 REMOVALS AND PREPERATIONS, Article 3.4 INSTALLATION OF NEW CEILING ACCESS PANEL:

Delete subparagraph 3.4.2 in its' entirety and add the following new subparagraph 3.4.2:

3.4.2 After the removal by OWNER of the drywall or plaster ceiling openings (approximately 14" x 32") between (2) adjacent joists. Contractor is to case the opening with 1x4 casing.

#### 5. CLARIFICATIONS TO THE DRAWINGS

- None
- 6. CHANGES TO THE DRAWINGS
  - R1 Added snow guards to the roof plan
  - D1 Removed "Optional" sealant choice in Detail 3 Sanitary Vent.
  - K1, R1, D1 and D2 reference to 95% Construction Documents is changed to "CONSTRUCTION DOCUMENTS".

#### 7. CONTRACTOR QUESTIONS DURING BID PERIOD

 A question was asked as to whether the Roofing Contractor will be responsible for removing the ceiling material at the interior ceiling view panels. The answer is No. USC will have this material removed prior to the roofing contractor performing their work.

Nothing herein is interpreted or construed as changing any provisions of the specifications except as specifically stated herein.

END OF ADDENDUM NO. 1

Attachment(s): Pre-Bid Sign-In Sheet (1 page)

Drawings K1, R1, D1 & D2 (4 pages)

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#### USC FY21 OPER PROJ-OLD OBSERVATORY RE-ROOF FY21000007 AUGUST 11, 2020 AT 10:00AM

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SWMBE Contractor?	Name	Company Name	Phone #	Email
S W M B E	Randy Eddington	Waynco Roofing	(704) 301-5597	randyeddington@hotmail.com
S W M B E	Kevin Nunnery	Nunnery Roofing & Remodeling	(803) 968-4459	kevin_nunnery@yahoo.com
S W M B E	Johnny White	JW Wyatt Construction & Roofing	(864) 612-5295	jwwyattconst@gmail.com
S W M B E	Brent Dunn	Bone Dry Roofing	(843) 614-1304	<u>bdunn@bonedry.net</u>
S W M B E	John Chan	Durable Slate Company	(240) 444-1657	jchan@durableslate.com
S W M B E	Blount Shepard	Shepard & Associates LLC	(803) 407-8284	blount@shepardandassociates.us
S W M B E	Adam Warren	Shepard & Associates LLC	(803) 407-8284	adam@shepardandassociates.us
S W M B E	Dale Branham	USC	(803) 312-5927	branhamd@fmc.sc.edu
S W M B E	Ty Russell	USC		
S W M B E	Hatice Hikmet	USC	(803) 777-9994	hikmeth@mailbox.sc.edu

	BUILDING CODE ANALYSIS	
SU	DJECT: Roof Recover Project at OLD OBSERVATORY BUILDI BMITTAL: [ ] SCHEMATIC [ ] DESIGN DEVELOPME [ X ] CONSTRUCTION DOCUMENT E: 07/10/2020 CODE & EDITION: 2015 IBC & 2009 I	NT
	BASIC BUILDING CODE INFORMATION	
		ROOF AREAS 1-3
CONSTRUC	EXISTING (ASSUMED MOST SIMILAR TO TYPE II-A)	
OCCUPANCY GRO	BUSINESS (B) Office/Education > 1 2th grade	
OCCUPANCY GRC	BUSINESS (B) Office/Education > 1 2th grade	
Does building require	[X]no []yes	
Does building have Accesso	[X] no [ ] yes SF %	
	[X]no []yes	
	Non separated (IBC 508.3)	[X]no []yes
Sepa	[X]no []yes	
OTHER FIRE PRO If the building has any special designers should list them he locations in cons smoke-evacuation	N/A	
	FIRE RESISTANCE RATING OF BUILDING ELEMENTS	
	As Required, Hrs	I HR
Roof Construction including	As Designed, Hrs	I HR
supporting beams \$ joists (IBC Table 601)	Testing Agency \$ Design No.(UL, FM, etc)	UL
	Wall/Partition Key Code	
	STRUCTURAL DESIGN INFORMATION, BUILDING	
WIND LOADS	ASCE 7-16	RISK CATEGORY III I 25 MPH
	ENERGY INFORMATION	
	INSULATION	
Roof	FIBERGLASS BATT INSULATION CONTINUOUS AT CEILING LEVEL (APPROXIMATELY > 20 R)	N/A AT ROOF DECK
	LLVLL (ALI NOMINIFATELT / ZO N	

## PROJECT DATA

A. PROJECT DESIGNED IN ACCORDANCE WITH:

I. INTERNATIONAL BUILDING CODE - 2015 EDITION 2. INTERNATIONAL PLUMBING CODE - 2015 EDITION

3. INTERNATIONAL FIRE CODE - 2015 EDITION

4. INTERNATIONAL EXISTING BUILDING CODE - 2015 EDITION

5. INTERNATIONAL ENERGY CONSERVATION CODE - 2009 EDITION

6. NATIONAL FIRE PROTECTION ASSOCIATION 10 - 2013 EDITION

B. BASIC REVIEW INFORMATION I. EXISTING STRUCTURE CONSISTS OF MULTI-WYTHE BRICK MASONRY WALLS WITH WOOD FRAMING AND DECKING, COVERED BY UNDERLAYMENT AND SLATE SHINGLES.

2. AREA OF AFFECTED ROOF (BASE BID): 528 SF a. RAI: 298 SF

c. RA3: 115 SF 3. ROOF HEIGHT ABOVE GRADE (ALL ARE APPROXIMATE):

a. RAI: 38'-42'

ь. RA2: I I 5 SF

b. RA2: 28'-31' c. RA3: 28'-31'

5. PRIMARY OCCUPANCY CLASS: GROUP "E" EDUCATION 6. CLASS "A" ROOF COVERING

C. PROJECT IN FIRE DISTRICT: YES

D. STRUCTURAL INFORMATION:

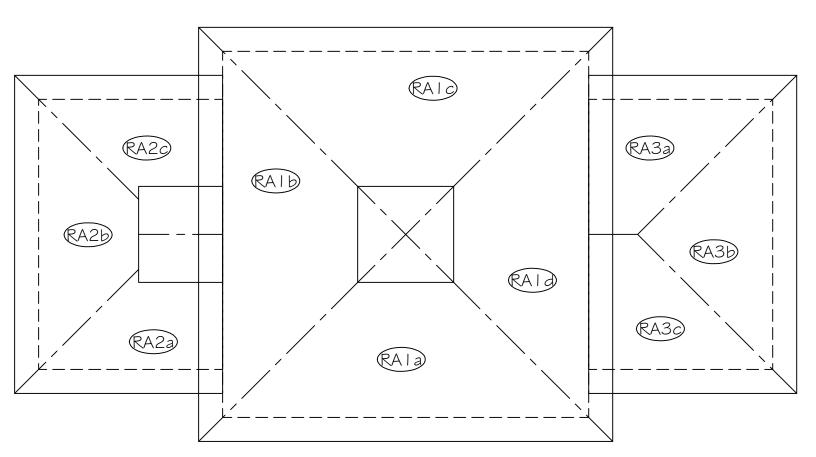
I. DESIGN LOADS: a. ORIGINAL DEAD LOAD INCLUDED SLATE

ESTIMATED WEIGHT: 4 lbs/SF b. PROPOSED DEAD LOAD INCLUDING SLATE

DESIGN WEIGHT: 4 lbs/SF c. NET DEAD LOAD WILL NOT CHANGE

## RECOVER ROOFING PROJECT AT OLD OBSERVATORY PENDLETON STREET COLUMBIA, SC 29208





OLD OBSERVATORY KEY PLAN



LEGEND

(RA #) = ROOF AREA LABEL

= AREA TO BE REPLACED

= AREA NOT IN CONTRACT


### DRAWING INDEX

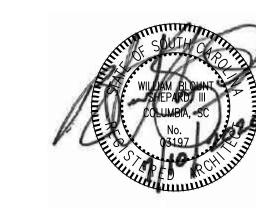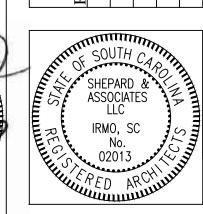
KEY PLAN, DRAWING INDEX \$ SITE VICINITY MAP

ROOF PLAN

DETAILS

DETAILS






PF 11012.022.004 DATE: 07/10/20 SCALE: NTS DRAWN: PIJ

SHEET

CHECKED: WBS



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OLD OBSERVATORY BUILDING ROOF PLAN
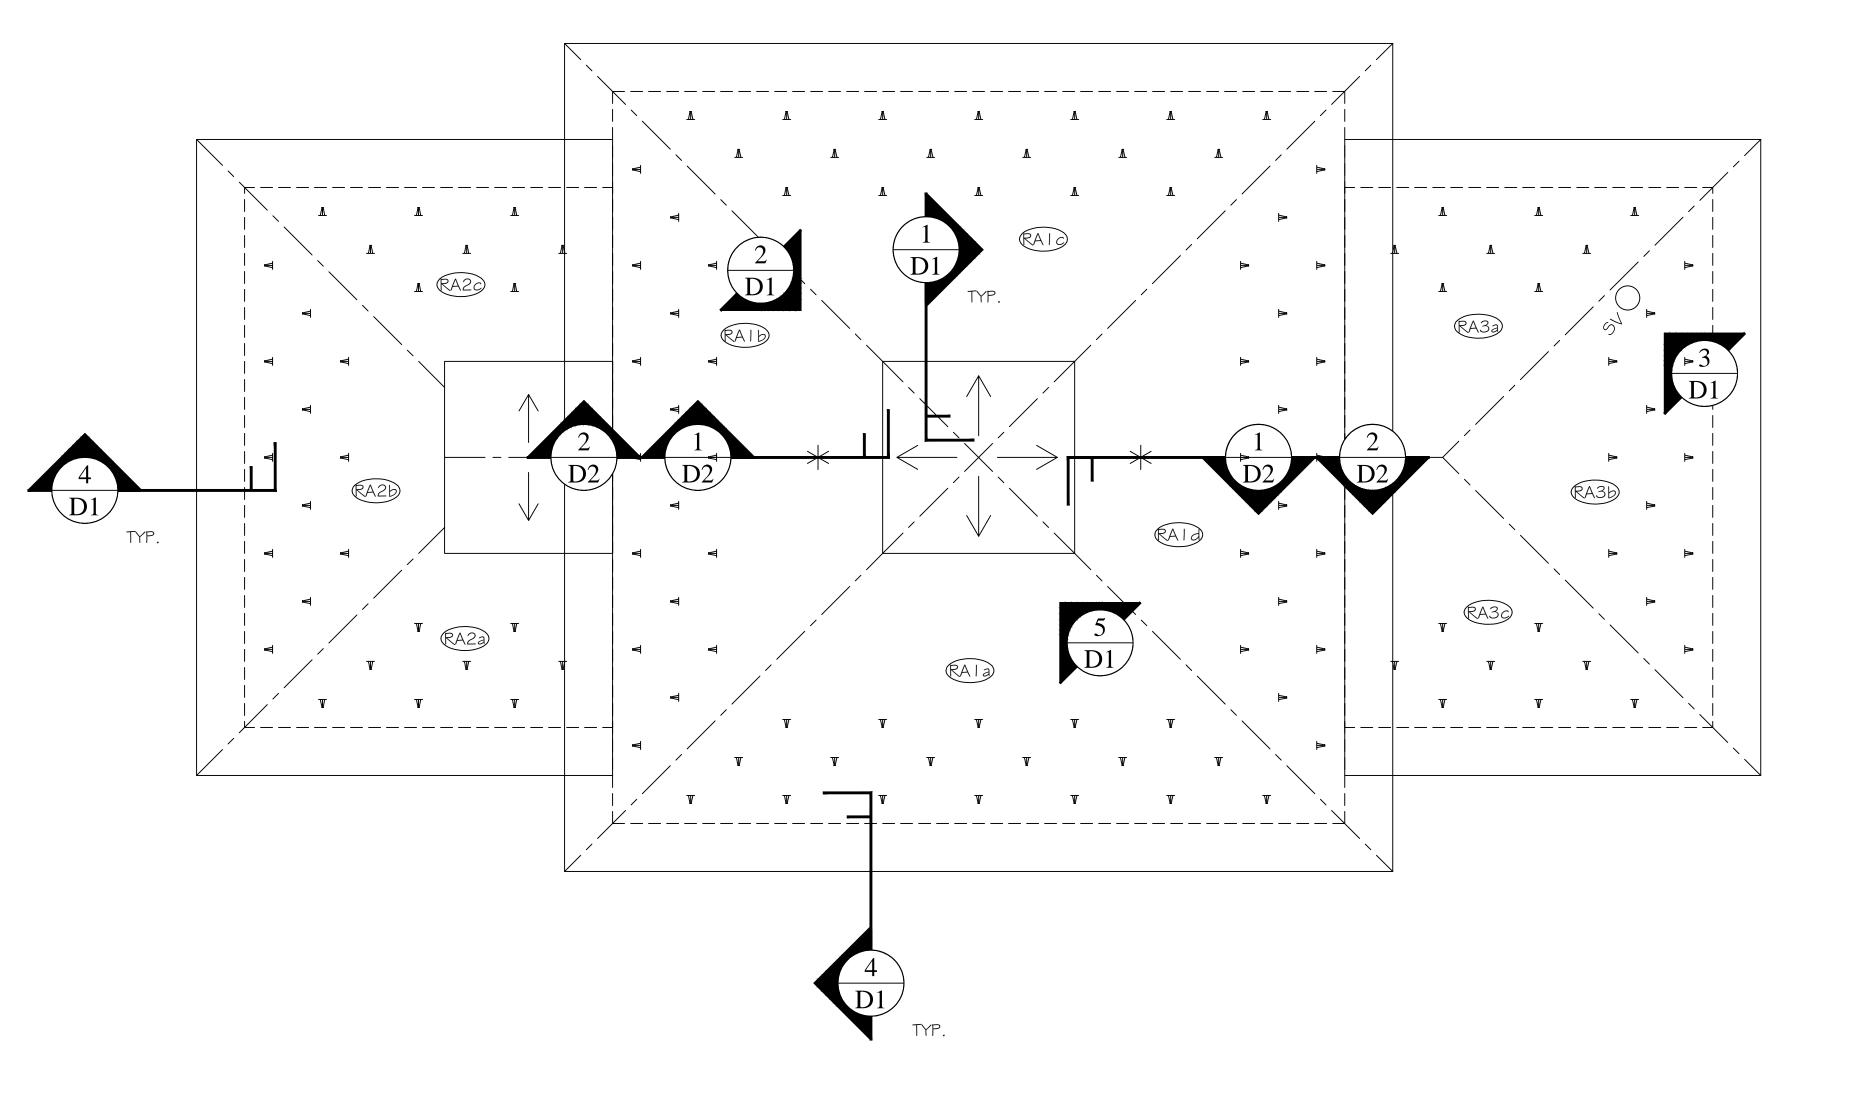
## LEGEND



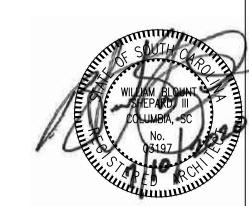
= DIRECTION OF ROOF SLOPE (SLOPE = 4.1/12 UNLESS OTHERWISE NOTED)

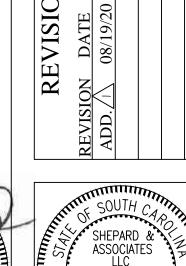
= EDGE OF ROOF
BUILDING LINE BELOW

°SV = SANITARY SEWER VENT

= FALL PROTECTION DEVICE


= SNOW GUARD






PROJECT DESCRIPTION: State Project Number: FY21000007

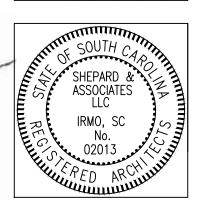
OLD OBSERVATORY BUILDING



PF 11012.022.004 DATE: 07/10/20 SCALE: NTS DRAWN: PIJ CHECKED: WBS

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5 APRON FLASHING AT SUMMIT

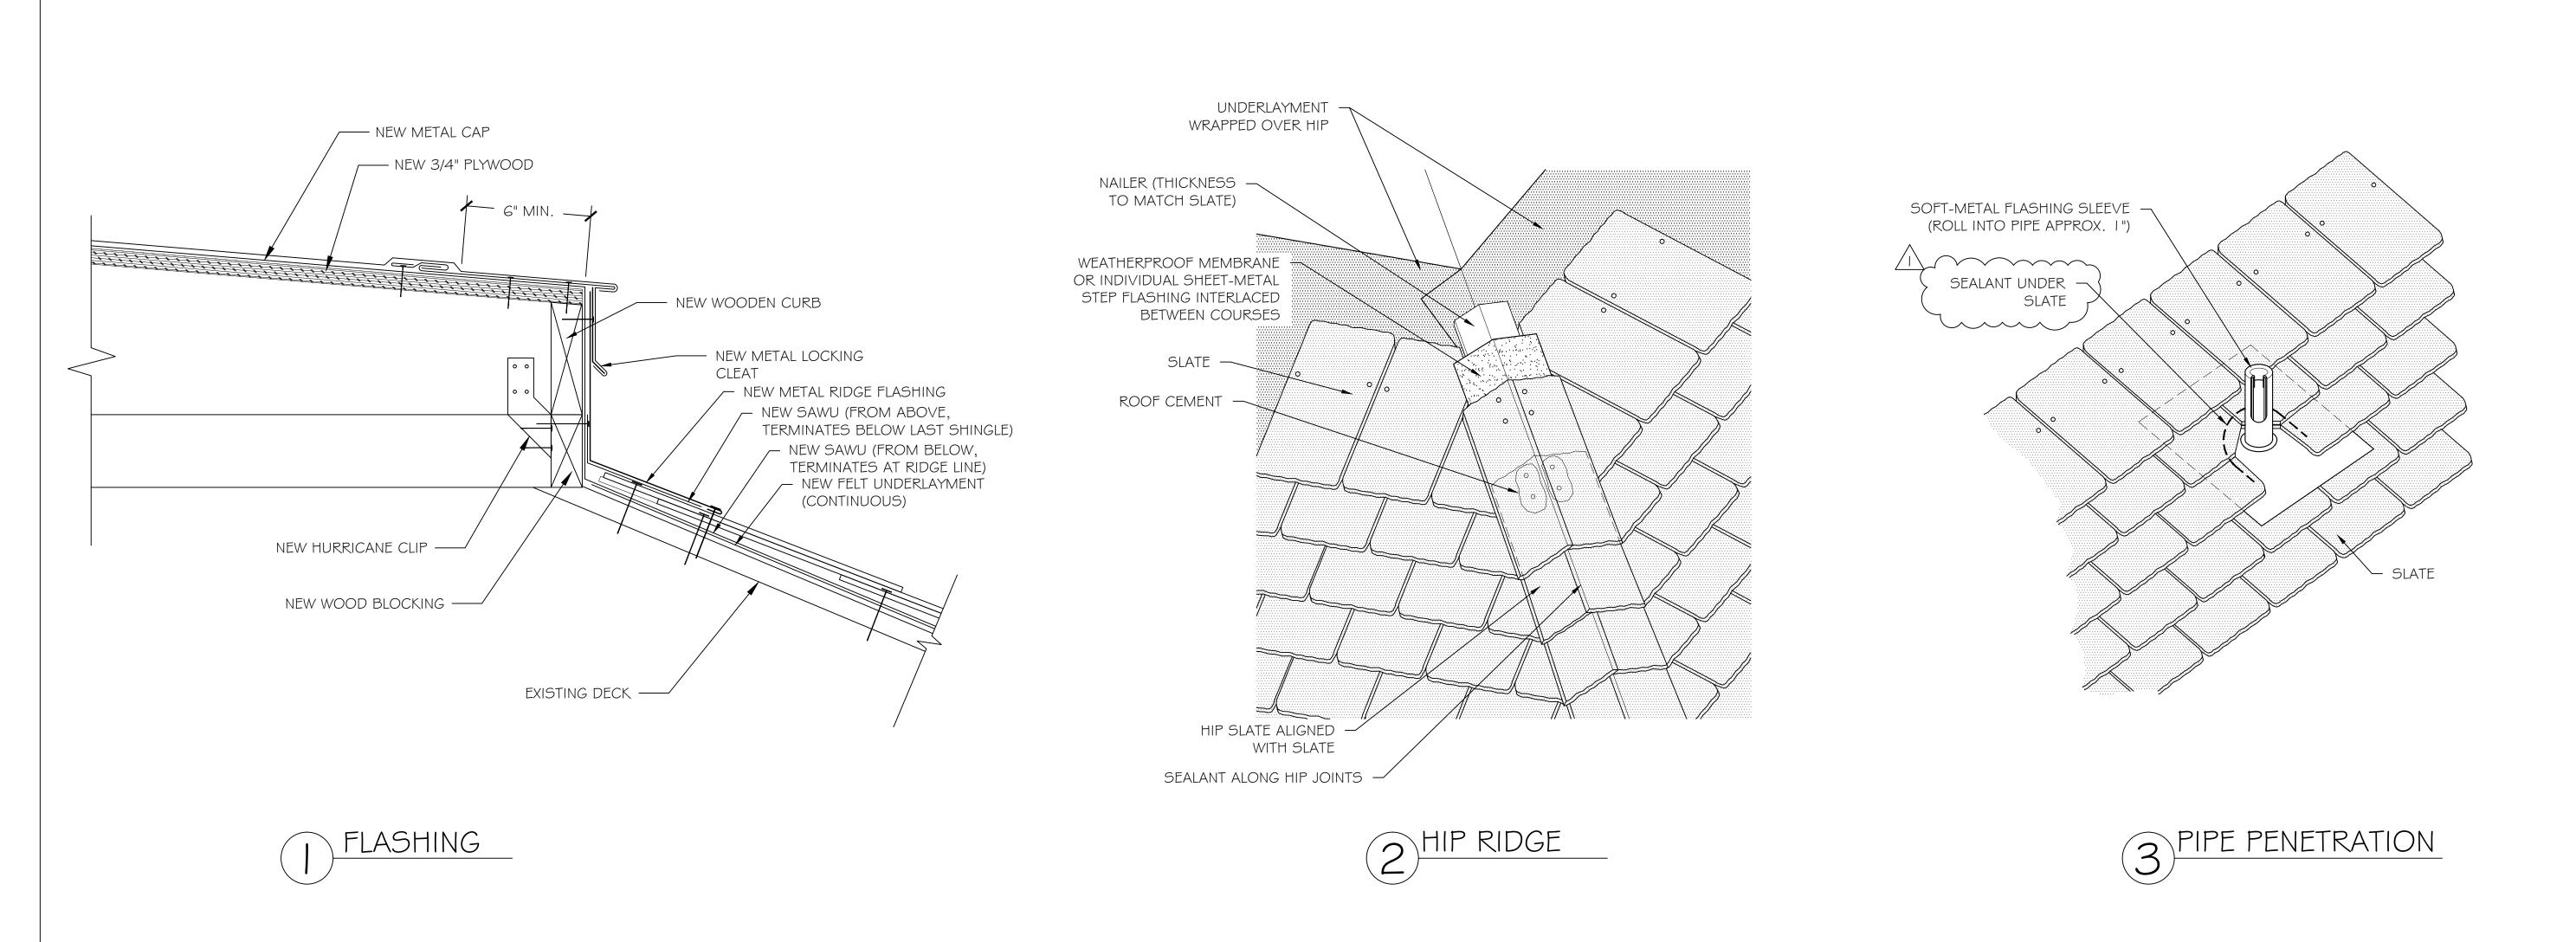9 1/2" EXPOSURE —

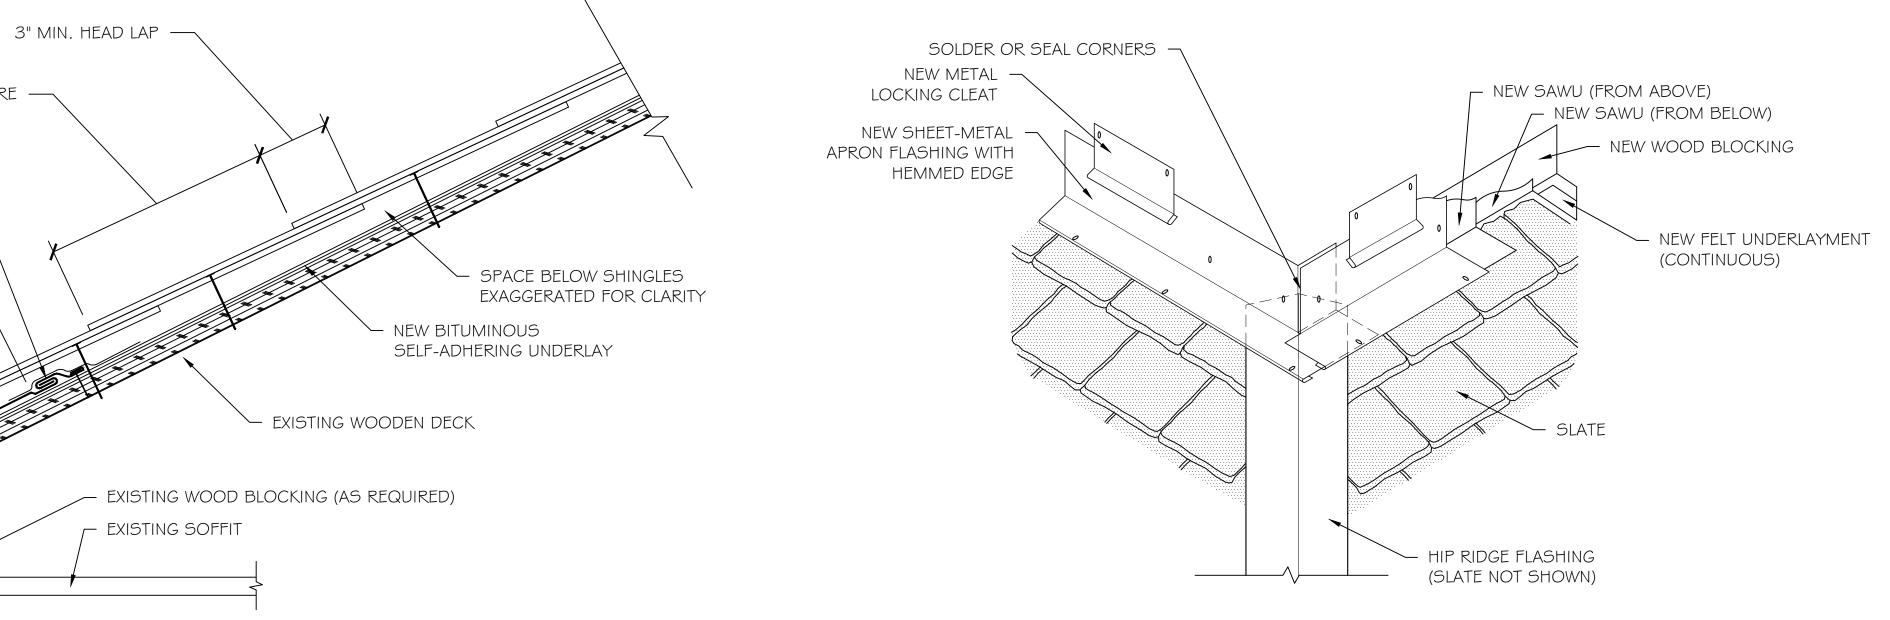METAL CLEAT @ 12" O.C. -

STARTER SHINGLE (12

6" MIN. APRON

FLASHING

SOLDER NEW

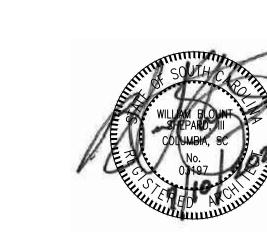
CONTINUOUS

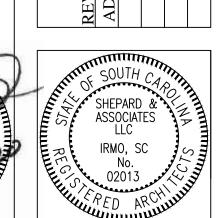
METAL CANT

NEW LOOSE LOCK APRON FLASHING

NEW LOCKING CLEAT

1/2" LENGTH)





Associates

8


Shepard

Details tate Project Number: FY21000007 SERVATORY BUILDING

PROJECT DESCRIPTION: StOLD OB

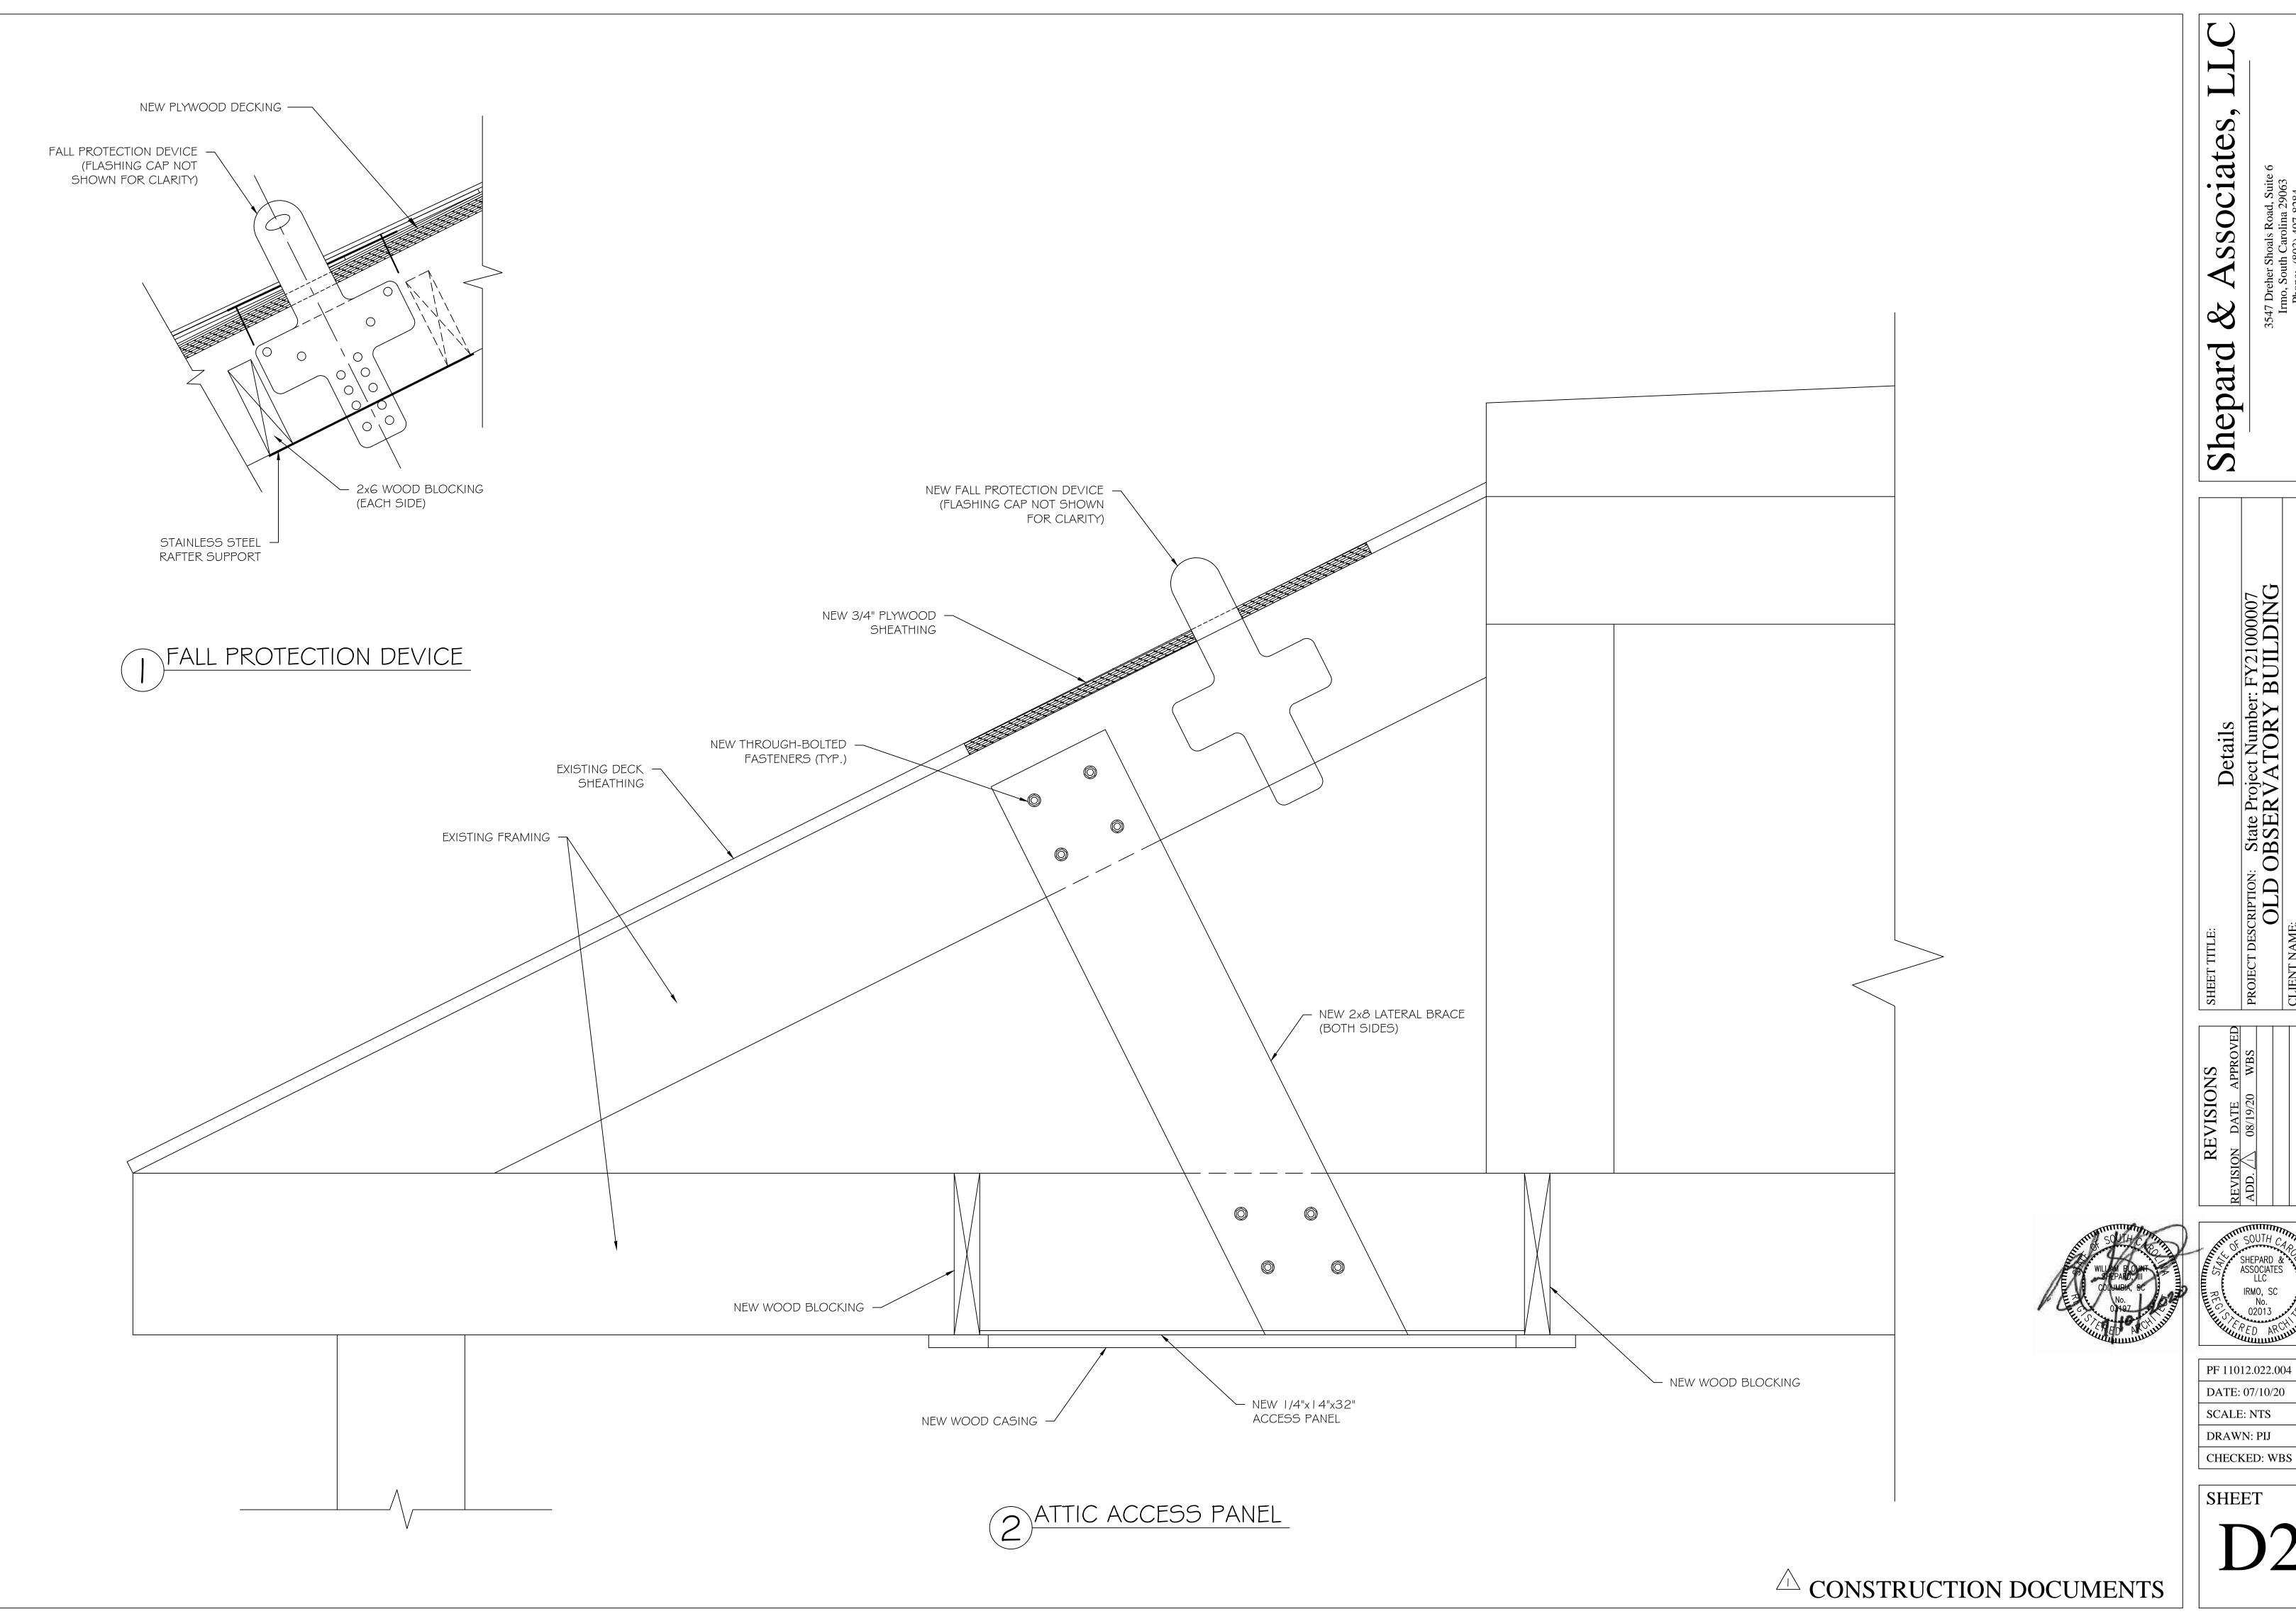PF 11012.022.004 DATE: 07/10/20 SCALE: NTS DRAWN: PIJ CHECKED: WBS

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Shepard